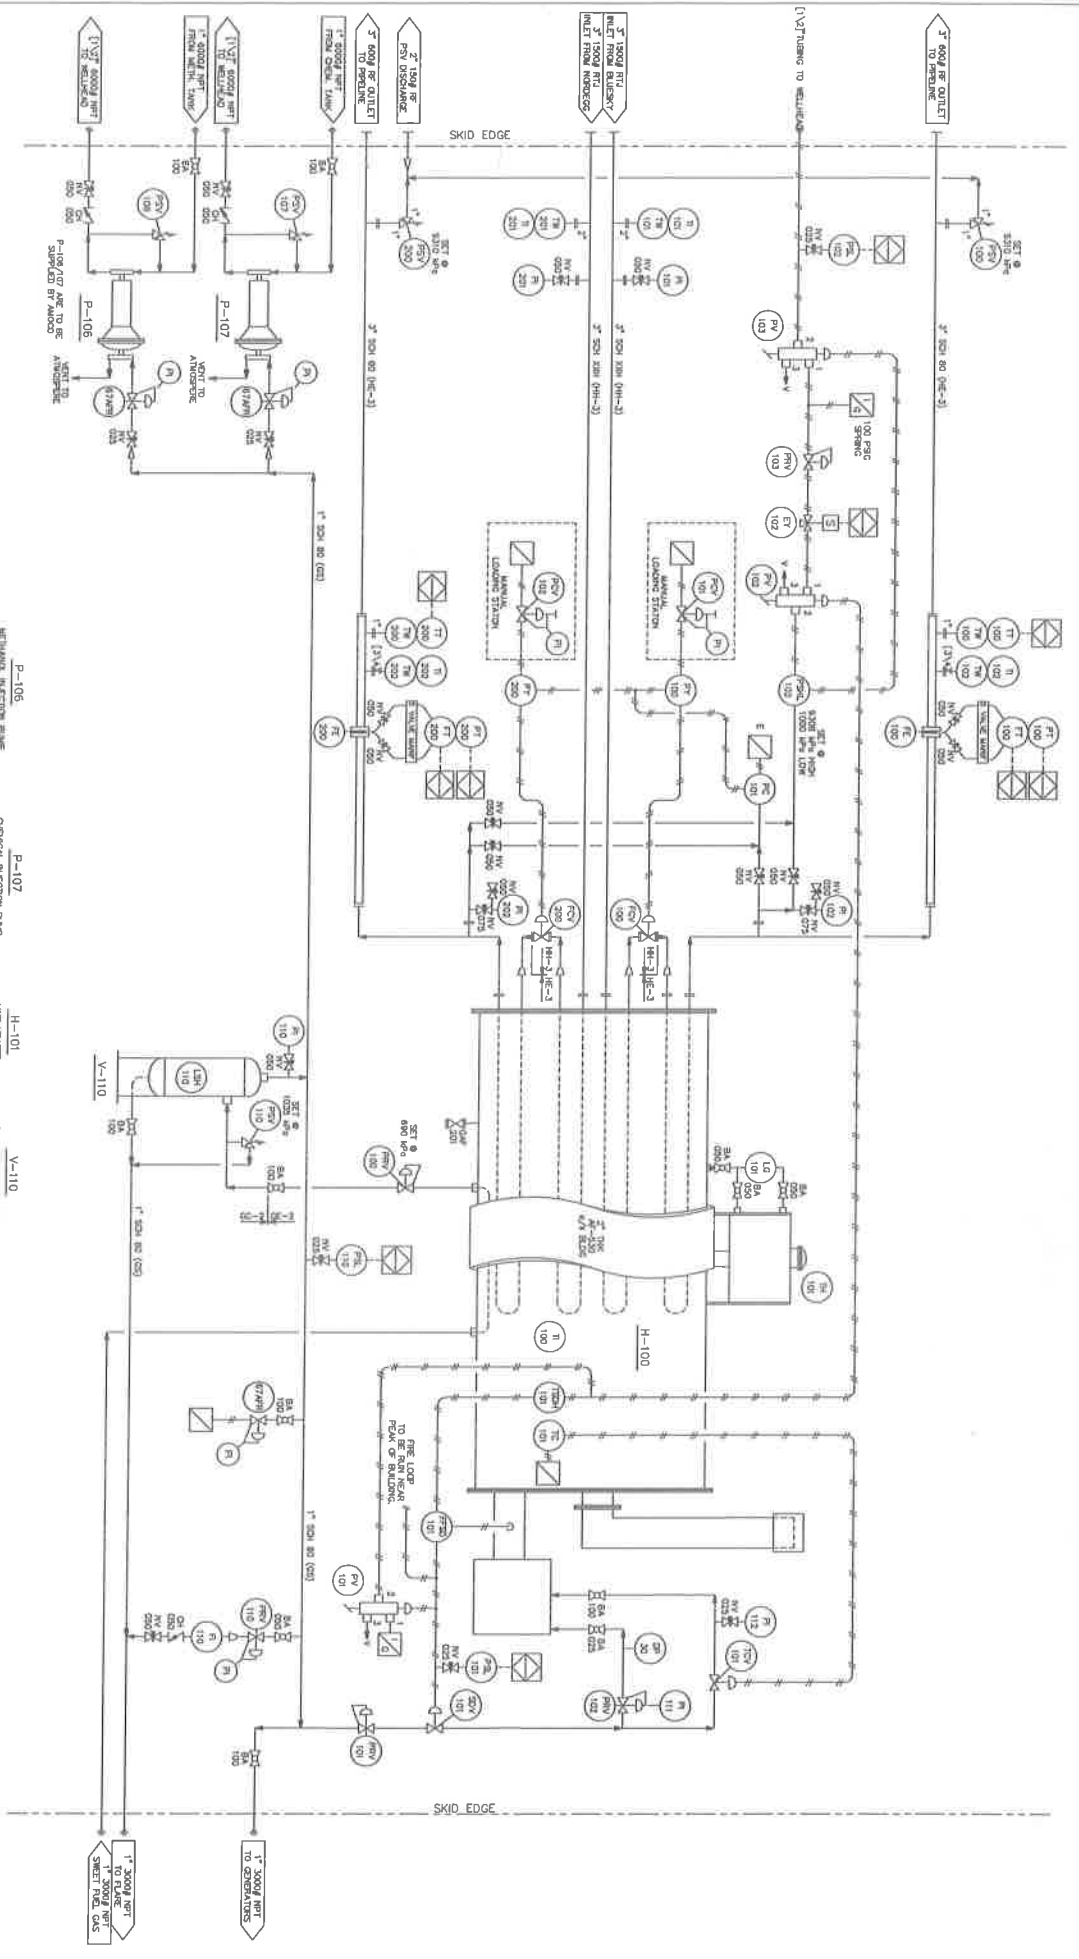


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LEGEND:
 = TO RVU


ITEM	DESCRIPTION	QTY	REV	DATE	BY	CHKD
1	MECHANICAL REACTION PUMP	2				
2	ORGANIC REACTION PUMP	2				
3	LINE HEATER	1				
4	FUEL GAS SCRUBBER	1				
5	FUEL GAS STORAGE	2				
6	3000 HPF SKID UNIT	4				
7	MANUAL LOADING STATION	2				
8	3000 HPF SKID UNIT	2				
9	3000 HPF SKID UNIT	2				
10	3000 HPF SKID UNIT	2				
11	3000 HPF SKID UNIT	2				
12	3000 HPF SKID UNIT	2				
13	3000 HPF SKID UNIT	2				
14	3000 HPF SKID UNIT	2				
15	3000 HPF SKID UNIT	2				
16	3000 HPF SKID UNIT	2				
17	3000 HPF SKID UNIT	2				
18	3000 HPF SKID UNIT	2				
19	3000 HPF SKID UNIT	2				
20	3000 HPF SKID UNIT	2				

PRESSON MANUFACTURING LTD.
 ENGINEERING - DESIGN - FABRICATION

NO.	REV.	DATE	BY	CHKD.	DESCRIPTION
1		02/18/74			ISSUE FOR CONSTRUCTION
2		02/18/74			ISSUE FOR CONSTRUCTION
3		02/18/74			ISSUE FOR CONSTRUCTION
4		02/18/74			ISSUE FOR CONSTRUCTION
5		02/18/74			ISSUE FOR CONSTRUCTION
6		02/18/74			ISSUE FOR CONSTRUCTION
7		02/18/74			ISSUE FOR CONSTRUCTION
8		02/18/74			ISSUE FOR CONSTRUCTION
9		02/18/74			ISSUE FOR CONSTRUCTION
10		02/18/74			ISSUE FOR CONSTRUCTION
11		02/18/74			ISSUE FOR CONSTRUCTION
12		02/18/74			ISSUE FOR CONSTRUCTION
13		02/18/74			ISSUE FOR CONSTRUCTION
14		02/18/74			ISSUE FOR CONSTRUCTION
15		02/18/74			ISSUE FOR CONSTRUCTION
16		02/18/74			ISSUE FOR CONSTRUCTION
17		02/18/74			ISSUE FOR CONSTRUCTION
18		02/18/74			ISSUE FOR CONSTRUCTION
19		02/18/74			ISSUE FOR CONSTRUCTION
20		02/18/74			ISSUE FOR CONSTRUCTION

AMOCO CANADA PETROLEUM CO. B5551-01
 PINE CREEK WELL TIE IN
 LSD 02-17-57-19 WSM
 LINE HEATER PACKAGE
 P & ID
 B5551-011

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PLAN VIEW

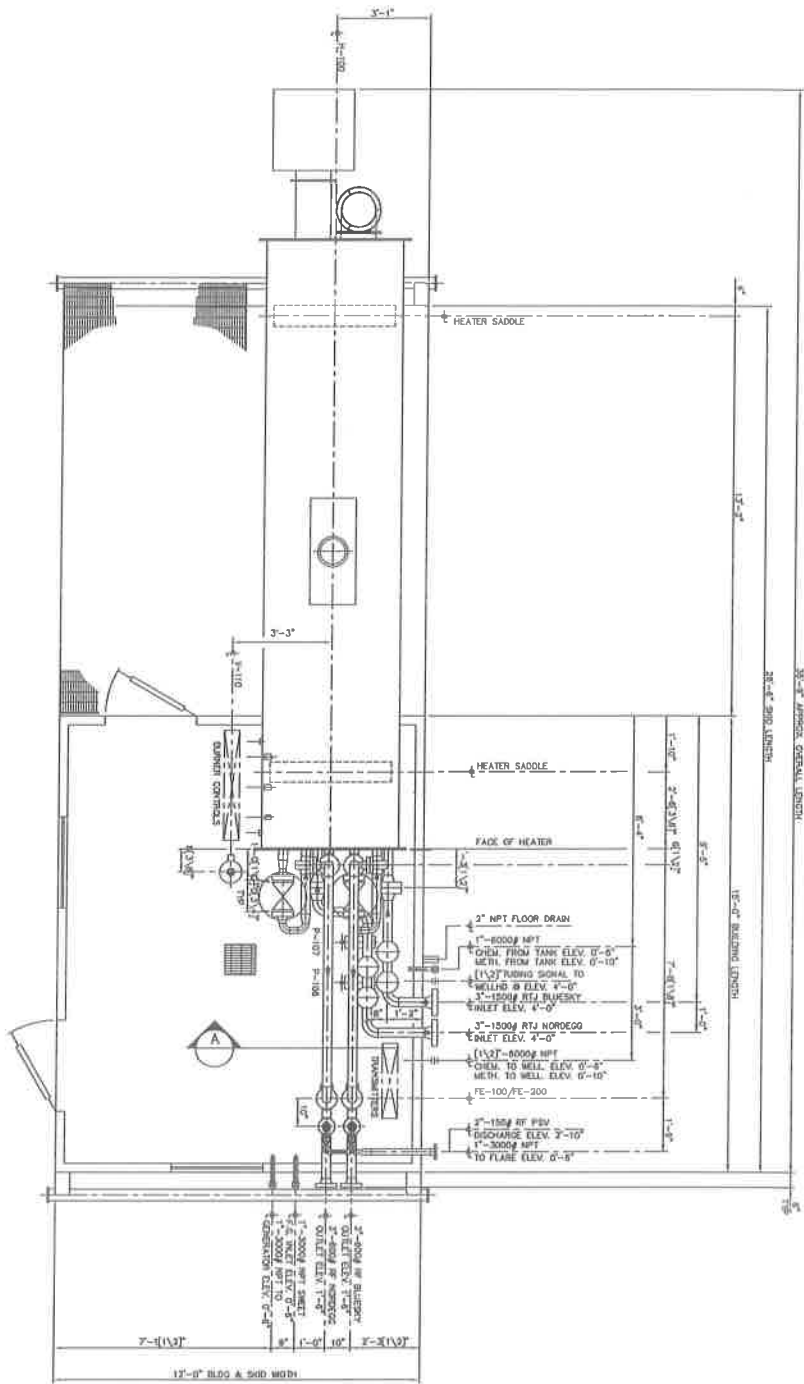

NOTES:
 1. ALL PIPING MATERIAL, WELDS AND FINISHES TO BE AS PER INSTANTANT LIST.
 2. ELEVATIONS SHOWN ARE FROM TOP OF ORDER PLATE. REF. ELEV. 0'-0".
 3. ESTIMATED WEIGHT: 28000 LBS.


NO.	DESCRIPTION	DATE	BY	CHKD.	APP.
1	DESIGN FOR CONSTRUCTION	2017/12/24	PL	PL	
2	RELOCATE R-100 & R-110	2017/12/24	PL	PL	



CLIENT	AMOCO CANADA PETROLEUM CO.	JOB NO.	B5551-01
PROJECT	PINE CREEK WELL TIE IN LSD 02-17-57-19 WSM	DATE	2017/12/24
DESCRIPTION	LINE HEATER PACKAGE GENERAL ARRANGEMENT	SCALE	1"=1'-0"
DATE	2017/12/24	ISSUE NO.	B5551-310

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BILL OF MATERIALS

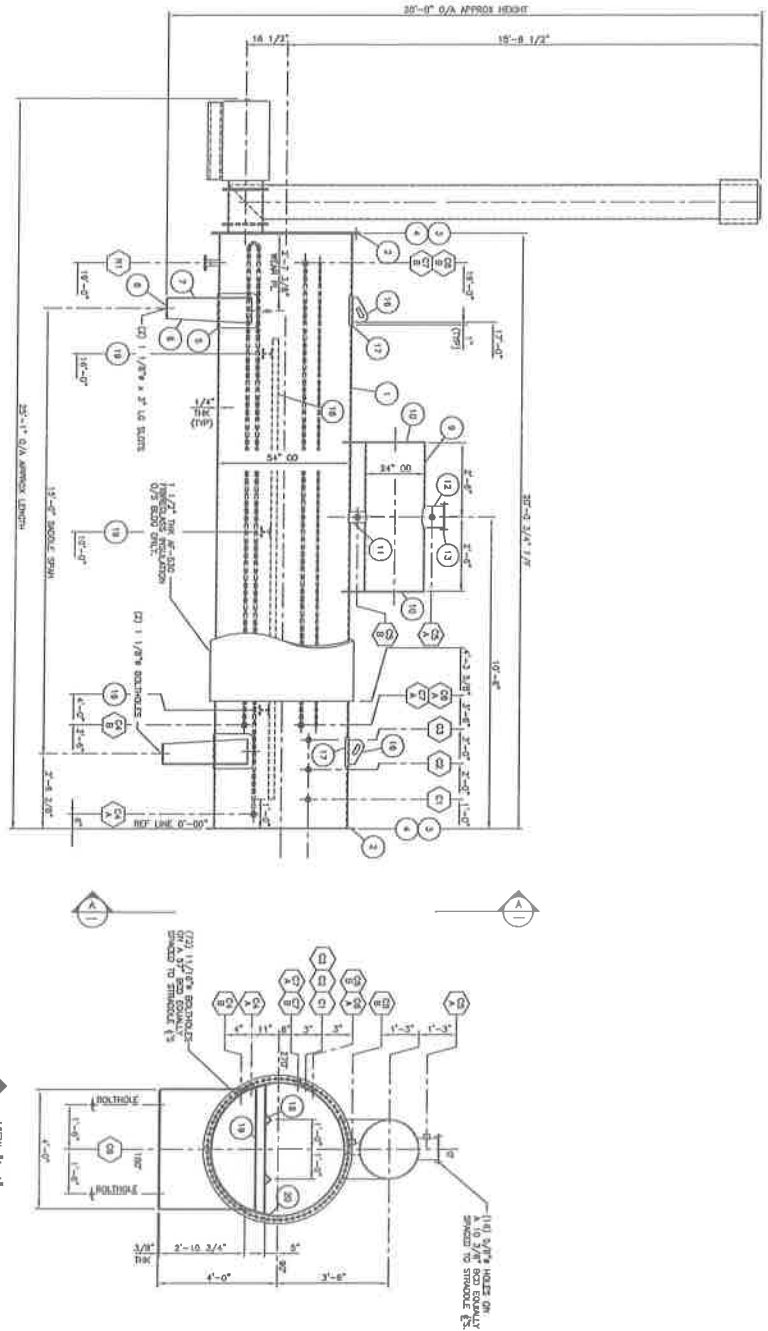

- NOTES:
- 1) HEATER TO HAVE RIGHT HAND CONTROLS WHEN VIEWED FROM REAR.
 - 2) DIMENSIONS ARE NON REMOVABLE.
 - 3) DIMENSIONS ARE NON REMOVABLE.
 - 4) DIMENSIONS ARE NON REMOVABLE.
 - 5) DIMENSIONS ARE NON REMOVABLE.
 - 6) DIMENSIONS ARE NON REMOVABLE.
 - 7) DIMENSIONS ARE NON REMOVABLE.
 - 8) DIMENSIONS ARE NON REMOVABLE.
 - 9) DIMENSIONS ARE NON REMOVABLE.
 - 10) DIMENSIONS ARE NON REMOVABLE.
 - 11) DIMENSIONS ARE NON REMOVABLE.
 - 12) DIMENSIONS ARE NON REMOVABLE.

NO.	QUANTITY	DESCRIPTION	UNIT	DATE
0	1	HEATER FOR CONSTRUCTION	EA	3/1/2018

PM
PRESSON
MANUFACTURING LTD.
EMPLOYEES - ENGINEERS - MANUFACTURERS

ITEM	QTY	DESCRIPTION	UNIT	REMARKS
1	1	SKILL	1	5A-38
2	1	FLANGE	1	5A-38
3	1	COVER	1	5A-40
4	1	WHEEL	1	5A-38
5	1	WHEEL	1	5A-38
6	1	WHEEL	1	5A-38
66	1	WHEEL	1	5A-38
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72	1	WHEEL	1	5A-38
73	1	WHEEL	1	5A-38
74	1	WHEEL	1	5A-38
75	1	WHEEL	1	5A-38
76	1	WHEEL	1	5A-38
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86	1	WHEEL	1	5A-38
87	1	WHEEL	1	5A-38
88	1	WHEEL	1	5A-38
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90	1	WHEEL	1	5A-38
91	1	WHEEL	1	5A-38
92	1	WHEEL	1	5A-38
93	1	WHEEL	1	5A-38
94	1	WHEEL	1	5A-38
95	1	WHEEL	1	5A-38
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97	1	WHEEL	1	5A-38
98	1	WHEEL	1	5A-38
99	1	WHEEL	1	5A-38
100	1	WHEEL	1	5A-38

AMOCO CANADA PETROLEUM CO. B5551-40


PINE OREX
LSD 02-17-57-19 WSM

1.0 MM BRU/HR INDIRECT FIRED HEATER
54" OD X 20'-0" 3/4" LG

DATE: 1/25/18
BY: 85/09/18
REV: B5551-410

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BILL OF MATERIALS

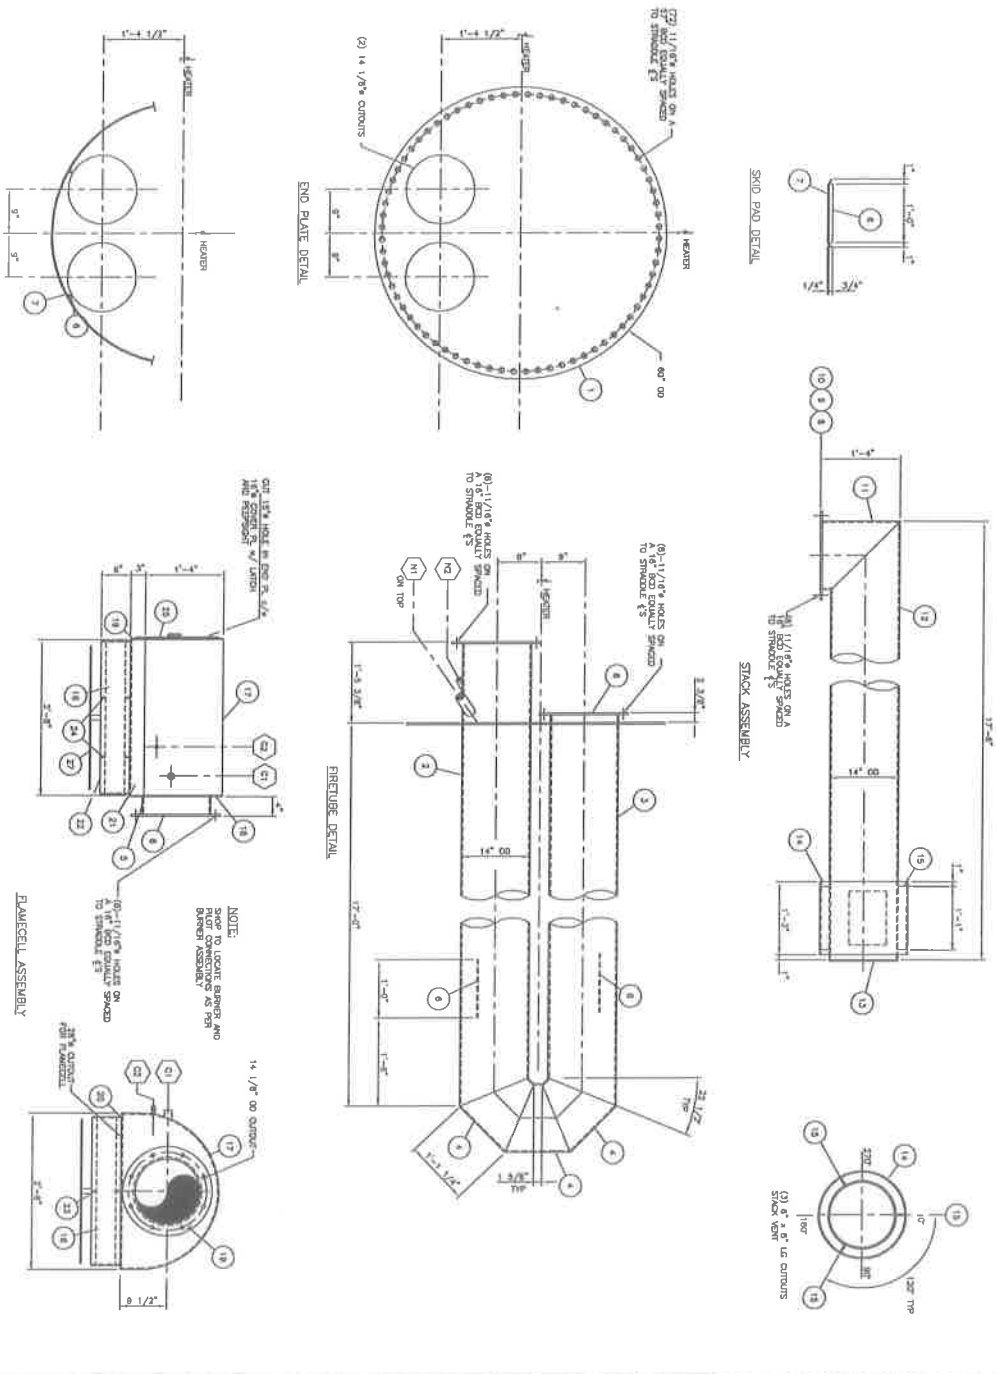

NO.	DESCRIPTION	QTY.	REMARKS
1	FRONT END PLATE	1	50-100
2	FRONT END PLATE	1	50-100
3	FRONT END PLATE	1	50-100
4	FRONT END PLATE	1	50-100
5	FRONT END PLATE	1	50-100
6	FRONT END PLATE	1	50-100
7	FRONT END PLATE	1	50-100
8	FRONT END PLATE	1	50-100
9	FRONT END PLATE	1	50-100
10	FRONT END PLATE	1	50-100
11	FRONT END PLATE	1	50-100
12	FRONT END PLATE	1	50-100
13	FRONT END PLATE	1	50-100
14	FRONT END PLATE	1	50-100
15	FRONT END PLATE	1	50-100
16	FRONT END PLATE	1	50-100
17	FRONT END PLATE	1	50-100
18	FRONT END PLATE	1	50-100
19	FRONT END PLATE	1	50-100
20	FRONT END PLATE	1	50-100
21	FRONT END PLATE	1	50-100
22	FRONT END PLATE	1	50-100
23	FRONT END PLATE	1	50-100
24	FRONT END PLATE	1	50-100
25	FRONT END PLATE	1	50-100
26	FRONT END PLATE	1	50-100
27	FRONT END PLATE	1	50-100

NOTES:

- 1) REFER TO Dwg NO. 88551-410 FOR GENERAL ASSEMBLY.
- 2) FLANGE DETAIL, HOUSING IS REMOVABLE.
- 3) REFER TO Dwg NO. 88551-410 FOR GENERAL ASSEMBLY.
- 4) REFER TO Dwg NO. 88551-410 FOR GENERAL ASSEMBLY.
- 5) 100% INSPECTION ON ALL PRESSON WELD JOINTS.

MANUFACTURING LTD.

1000, 000 RD. / 400, 000 RD. / 1000, 000 RD.

88551-410

BILL OF MATERIALS


NO.	REV.	DESCRIPTION	QTY.	UOM.
1	END PLATE	60" OD x 7/8" TH	1	SA-105H
2	SUPPORT PL.	6'-2 1/2" W x 3/4" TH x 3'-4" LG	3	SA-105H
3	SUPPORT	3" x 3" x 3/4" ANGLE x 18'-8" LG	2	SA-105H
4	NI A	2" 1500L S01 200 STEAM FLD	1	SA-105H
5	NI A	2" 1500L S01 200 RETURN FLD	1	SA-105H
6	NI B	2" S01 200 S01 200 STEAM FLD	1	SA-105H
7	NI B	2" S01 200 S01 200 RETURN FLD	1	SA-105H
8	NI B	2" S01 200 S01 200 STEAM FLD	1	SA-105H
9	NI B	2" S01 200 S01 200 RETURN FLD	1	SA-105H
10	NI B	2" S01 200 S01 200 STEAM FLD	1	SA-105H
11	NI B	2" S01 200 S01 200 RETURN FLD	1	SA-105H
12	NI A	2" 600L S01 200 STEAM FLD	1	SA-105H
13	NI B	2" 600L S01 200 RETURN FLD	1	SA-105H
14	NI B	2" S01 200 S01 200 STEAM FLD	1	SA-105H
15	NI B	2" S01 200 S01 200 RETURN FLD	1	SA-105H
16	NI B	2" S01 200 S01 200 STEAM FLD	1	SA-105H
17	NI B	2" S01 200 S01 200 RETURN FLD	1	SA-105H
18	NI B	2" S01 200 S01 200 STEAM FLD	1	SA-105H
19	NI B	2" S01 200 S01 200 RETURN FLD	1	SA-105H
20	NI A	2" 1500L S01 200 STEAM FLD	1	SA-105H
21	NI B	2" 1500L S01 200 RETURN FLD	1	SA-105H
22	NI B	2" S01 200 S01 200 STEAM FLD	1	SA-105H
23	NI B	2" S01 200 S01 200 RETURN FLD	1	SA-105H
24	NI B	2" S01 200 S01 200 STEAM FLD	1	SA-105H
25	NI B	2" S01 200 S01 200 RETURN FLD	1	SA-105H
26	NI B	2" S01 200 S01 200 STEAM FLD	1	SA-105H
27	NI B	2" S01 200 S01 200 RETURN FLD	1	SA-105H
28	NI A	2" 600L S01 200 STEAM FLD	1	SA-105H
29	NI B	2" 600L S01 200 RETURN FLD	1	SA-105H
30	NI B	2" S01 200 S01 200 STEAM FLD	1	SA-105H
31	NI B	2" S01 200 S01 200 RETURN FLD	1	SA-105H
32	NI B	2" S01 200 S01 200 STEAM FLD	1	SA-105H
33	NI B	2" S01 200 S01 200 RETURN FLD	1	SA-105H
34	NI B	2" S01 200 S01 200 STEAM FLD	1	SA-105H
35	NI B	2" S01 200 S01 200 RETURN FLD	1	SA-105H

NOTES
 1) AMOCO APPROVED WELD PROCEDURES ONE T.
 2) WELDS UNDERSTOOD NOT TO EXCEED 20% OF
 3) FOR ALL WELDS TO BE MADE IN ACCORDANCE WITH
 ASME SECTION VIII DIVISION 1 (SAFETY) OR
 ASME SECTION VIII DIVISION 2 (NORMAL TEMPERATURE)
 CODE AND FOR FLANGED FITTINGS & PIPE


COIL DESIGN DATA

DESIGN AND FABRICATE ACCORDING TO ANSI B31.3 AND B16.5, 1986 EDITION.
 REGISTER WITH THE ALBERTA BOILERS BRANCH.


ITEM	DESCRIPTION	QTY.	UOM.	REMARKS
1	COIL	1	EA	AS PER DETAIL
2	END PLATE	1	EA	AS PER DETAIL
3	SUPPORT PL.	3	EA	AS PER DETAIL
4	SUPPORT	2	EA	AS PER DETAIL
5	NI A	1	EA	AS PER DETAIL
6	NI B	1	EA	AS PER DETAIL
7	NI B	1	EA	AS PER DETAIL
8	NI B	1	EA	AS PER DETAIL
9	NI B	1	EA	AS PER DETAIL
10	NI B	1	EA	AS PER DETAIL
11	NI B	1	EA	AS PER DETAIL
12	NI A	1	EA	AS PER DETAIL
13	NI B	1	EA	AS PER DETAIL
14	NI B	1	EA	AS PER DETAIL
15	NI B	1	EA	AS PER DETAIL
16	NI B	1	EA	AS PER DETAIL
17	NI B	1	EA	AS PER DETAIL
18	NI B	1	EA	AS PER DETAIL
19	NI B	1	EA	AS PER DETAIL
20	NI A	1	EA	AS PER DETAIL
21	NI B	1	EA	AS PER DETAIL
22	NI B	1	EA	AS PER DETAIL
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24	NI B	1	EA	AS PER DETAIL
25	NI B	1	EA	AS PER DETAIL
26	NI B	1	EA	AS PER DETAIL
27	NI B	1	EA	AS PER DETAIL
28	NI A	1	EA	AS PER DETAIL
29	NI B	1	EA	AS PER DETAIL
30	NI B	1	EA	AS PER DETAIL
31	NI B	1	EA	AS PER DETAIL
32	NI B	1	EA	AS PER DETAIL
33	NI B	1	EA	AS PER DETAIL
34	NI B	1	EA	AS PER DETAIL
35	NI B	1	EA	AS PER DETAIL

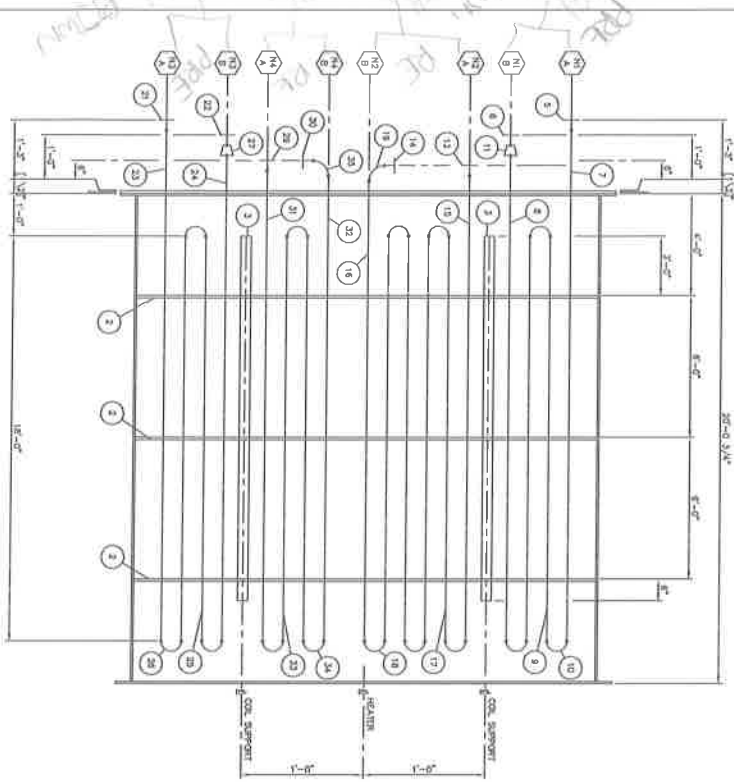

COIL SCHEMATIC

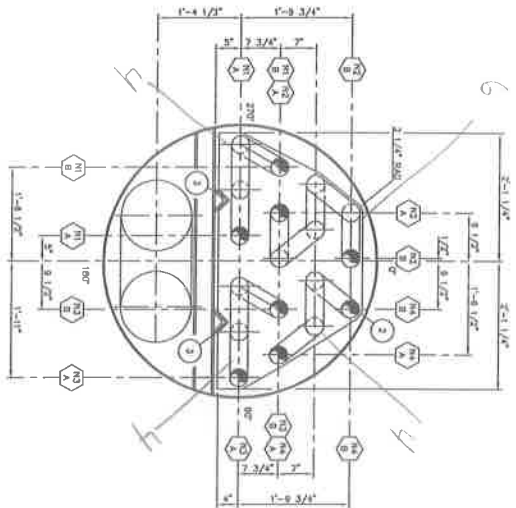

COIL LAYOUT

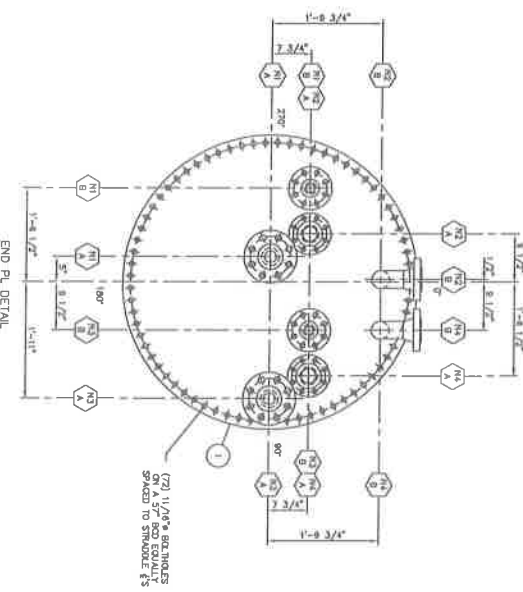

END PL. DETAIL

NO.	REV.	DESCRIPTION	DATE
0		ISSUED FOR CONSTRUCTION	04/29/78
1			
2			
3			
4			
5			
6			
7			
8			
9			




ITEM	DESCRIPTION	QTY.	UOM.	REMARKS
1	COIL	1	EA	AS PER DETAIL
2	END PLATE	1	EA	AS PER DETAIL
3	SUPPORT PL.	3	EA	AS PER DETAIL
4	SUPPORT	2	EA	AS PER DETAIL
5	NI A	1	EA	AS PER DETAIL
6	NI B	1	EA	AS PER DETAIL
7	NI B	1	EA	AS PER DETAIL
8	NI B	1	EA	AS PER DETAIL
9	NI B	1	EA	AS PER DETAIL
10	NI B	1	EA	AS PER DETAIL
11	NI B	1	EA	AS PER DETAIL
12	NI A	1	EA	AS PER DETAIL
13	NI B	1	EA	AS PER DETAIL
14	NI B	1	EA	AS PER DETAIL
15	NI B	1	EA	AS PER DETAIL
16	NI B	1	EA	AS PER DETAIL
17	NI B	1	EA	AS PER DETAIL
18	NI B	1	EA	AS PER DETAIL
19	NI B	1	EA	AS PER DETAIL
20	NI A	1	EA	AS PER DETAIL
21	NI B	1	EA	AS PER DETAIL
22	NI B	1	EA	AS PER DETAIL
23	NI B	1	EA	AS PER DETAIL
24	NI B	1	EA	AS PER DETAIL
25	NI B	1	EA	AS PER DETAIL
26	NI B	1	EA	AS PER DETAIL
27	NI B	1	EA	AS PER DETAIL
28	NI A	1	EA	AS PER DETAIL
29	NI B	1	EA	AS PER DETAIL
30	NI B	1	EA	AS PER DETAIL
31	NI B	1	EA	AS PER DETAIL
32	NI B	1	EA	AS PER DETAIL
33	NI B	1	EA	AS PER DETAIL
34	NI B	1	EA	AS PER DETAIL
35	NI B	1	EA	AS PER DETAIL


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BILL OF MATERIALS

ITEM	QTY	DESCRIPTION	UNIT
1	2	MAIN BEAM	Q0231-448
2	2	MAIN BEAM	Q0231-448
3	2	MAIN BEAM	Q0231-448
4	2	MAIN BEAM	Q0231-448
5	2	MAIN BEAM	Q0231-448
6	2	MAIN BEAM	Q0231-448
7	2	MAIN BEAM	Q0231-448
8	2	MAIN BEAM	Q0231-448
9	2	MAIN BEAM	Q0231-448
10	2	MAIN BEAM	Q0231-448
11	2	MAIN BEAM	Q0231-448
12	2	MAIN BEAM	Q0231-448
13	2	MAIN BEAM	Q0231-448
14	2	MAIN BEAM	Q0231-448
15	2	MAIN BEAM	Q0231-448
16	2	MAIN BEAM	Q0231-448
17	2	MAIN BEAM	Q0231-448
18	2	MAIN BEAM	Q0231-448
19	2	MAIN BEAM	Q0231-448
20	2	MAIN BEAM	Q0231-448
21	2	MAIN BEAM	Q0231-448
22	2	MAIN BEAM	Q0231-448
23	2	MAIN BEAM	Q0231-448
24	2	MAIN BEAM	Q0231-448
25	2	MAIN BEAM	Q0231-448
26	2	MAIN BEAM	Q0231-448
27	2	MAIN BEAM	Q0231-448
28	2	MAIN BEAM	Q0231-448
29	2	MAIN BEAM	Q0231-448
30	2	MAIN BEAM	Q0231-448
31	2	MAIN BEAM	Q0231-448
32	2	MAIN BEAM	Q0231-448
33	2	MAIN BEAM	Q0231-448
34	2	MAIN BEAM	Q0231-448
35	2	MAIN BEAM	Q0231-448
36	2	MAIN BEAM	Q0231-448
37	2	MAIN BEAM	Q0231-448

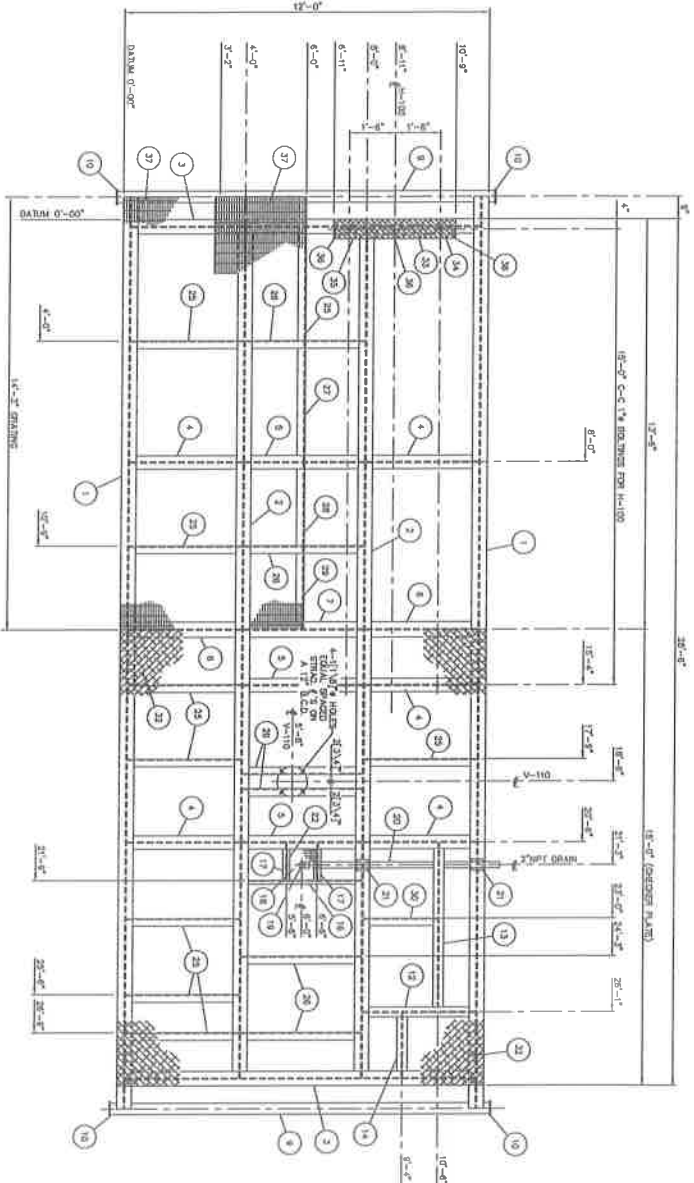

PLAN VIEW

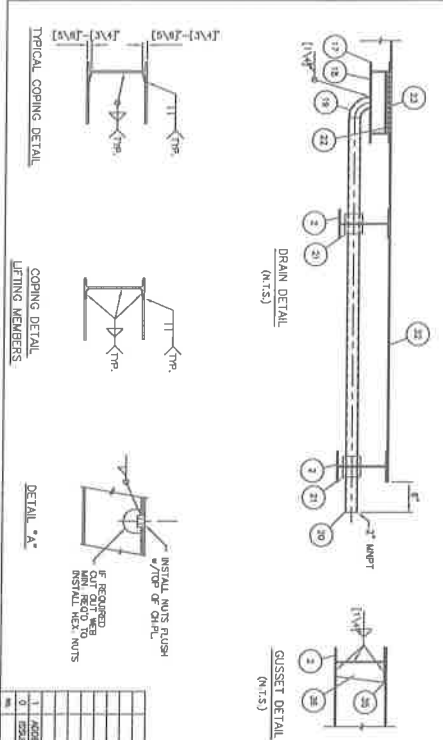

NO.	DESCRIPTION	QTY	DATE	BY	CHKD.
1	ADD HEIGHT SPOKE SUPPORT GUSSET	ONE	5/17/23		
2	SIZE FOR CONSTRUCTION		5/17/23		

1521-4

PRESSON
MANUFACTURING LTD.
MANUFACTURING - SERVICE - FABRICATING

AMOCO CANADA PETROLEUM CO. B5551-10

PINE CREEK WGL TIE-IN
LSD 02-17-57-19 WSM

LINE HEATER PACKAGE (OIL ZONE)
SMD: 12'-0" WIDE x 26'-6" LG x W10" @ 26#

DATE: 5/17/23

BY: [Signature]



CHKD: [Signature]

PROJECT: B5551-110

- NOTES:
1. ALL DIMENSIONS ARE FROM TOP OF OR GROUND PLATE, UNLESS NOTED OTHERWISE.
 2. GROUND PLATE FLOOR TO BE STITCH WELDED TO ALL SPOKE MEMBERS AND PERIMETER CONNECTIONS AND WELDED TO ALL SPOKE MEMBERS.
 3. INSULATE UNDERSIDE BUILDING AREA w/ 2"THK. SFEATHANE 40 FOAM INSULATION 4/4"
 4. PAINT ONE COAT INTERIOR FINISH AND ONE COAT EXTERIOR FINISH w/ ONE COAT INTERIOR FINISH AND ONE COAT EXTERIOR FINISH.
 5. PAINT AND ONE COAT INTERIOR FINISH AND ONE COAT EXTERIOR FINISH.
 6. DIMENSIONS SHOWN UNLESS NOTED OTHERWISE.

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BILL OF MATERIALS

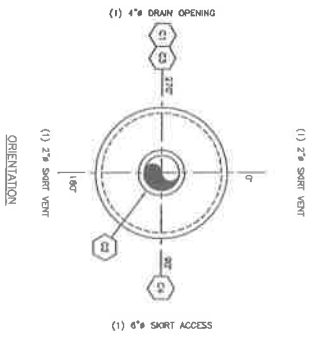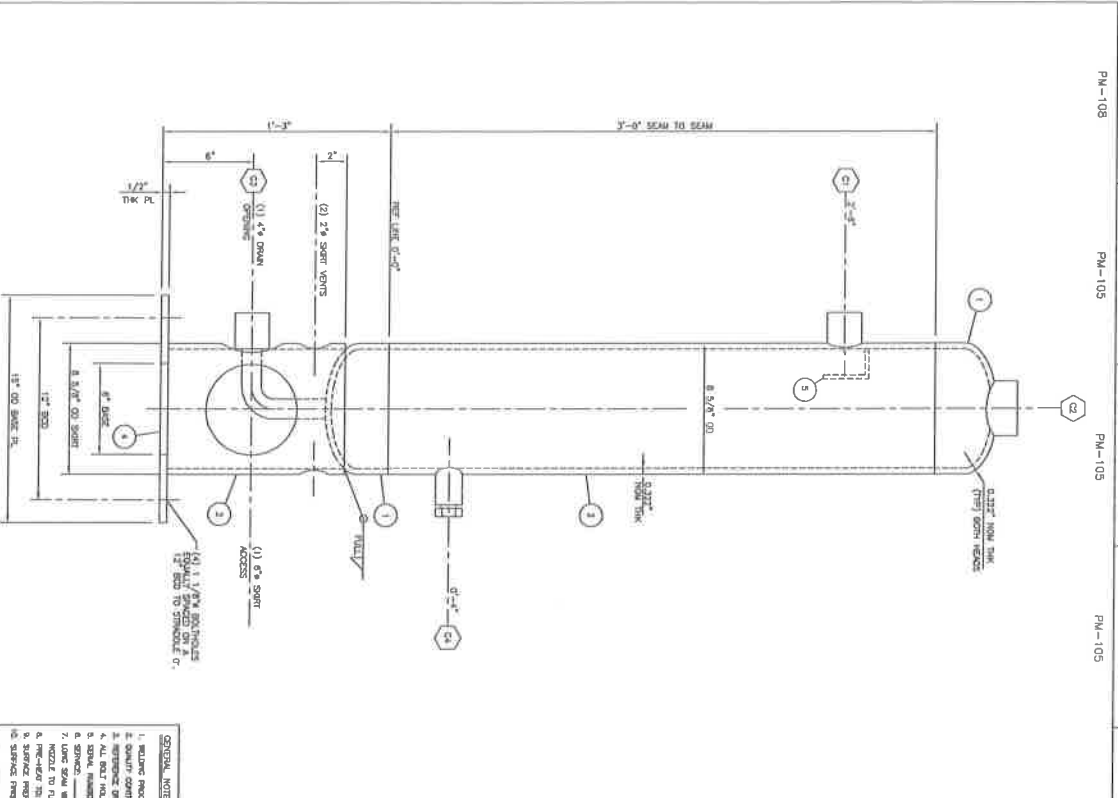

- GENERAL NOTES**
1. WELD PROCEDURES W-713.2
 2. QUALITY CONTROL PROGRAM QP-107
 3. ALL DIMENSIONS UNLESS OTHERWISE SPECIFIED ARE IN INCHES
 4. ALL DIMENSIONS TO CENTER UNLESS OTHERWISE SPECIFIED
 5. DIMENSIONS TO SURFACE UNLESS OTHERWISE SPECIFIED
 6. SURFACE FINISH: 320-360 RA
 7. WELD SYMBOLS: SEE WELDING SYMBOLS
 8. SURFACE FROM INT. TO EXTERIOR: 320-360 RA
 9. SURFACE FROM EXT. TO INTERIOR: 320-360 RA
 10. SURFACE FROM INT. TO INT. AND EXT. TO EXT.: 320-360 RA
 11. MATERIALS: SEE MATERIALS

- NOTES**
- 12) VESSEL IS SUBJECT TEST EQUIPMENT FOR UG-200.
 - 13) 100% INSPECTION.

GENERAL DATA

REV: DWG. 04-110 CENL 64974.2

DATE: 04-11-1988 DESIGNED BY: J. L. DRAWN BY: J. L. CHECKED BY: J. L. APPROVED BY: J. L.

PROJECT: PINE CREEK SHEET NO.: 11 OF 12

MANUFACTURER: PRESSON MANUFACTURING LTD.

ITEM NO.	DESCRIPTION	QTY	UNIT	MARK	REV
1	HEAD	1	54-105	W1-2	
2	SKIRT	1	54-105	W1-2	
3	DRUM	1	54-105	W1-2	
4	FEED INLET	1	54-105	W1-2	
5	FEED INLET	1	54-105	W1-2	
6	FEED INLET	1	54-105	W1-2	
7	FEED INLET	1	54-105	W1-2	
8	FEED INLET	1	54-105	W1-2	
9	FEED INLET	1	54-105	W1-2	
10	FEED INLET	1	54-105	W1-2	
11	FEED INLET	1	54-105	W1-2	
12	FEED INLET	1	54-105	W1-2	
13	FEED INLET	1	54-105	W1-2	
14	FEED INLET	1	54-105	W1-2	
15	FEED INLET	1	54-105	W1-2	
16	FEED INLET	1	54-105	W1-2	
17	FEED INLET	1	54-105	W1-2	
18	FEED INLET	1	54-105	W1-2	
19	FEED INLET	1	54-105	W1-2	
20	FEED INLET	1	54-105	W1-2	
21	FEED INLET	1	54-105	W1-2	
22	FEED INLET	1	54-105	W1-2	
23	FEED INLET	1	54-105	W1-2	
24	FEED INLET	1	54-105	W1-2	
25	FEED INLET	1	54-105	W1-2	
26	FEED INLET	1	54-105	W1-2	
27	FEED INLET	1	54-105	W1-2	
28	FEED INLET	1	54-105	W1-2	
29	FEED INLET	1	54-105	W1-2	
30	FEED INLET	1	54-105	W1-2	
31	FEED INLET	1	54-105	W1-2	
32	FEED INLET	1	54-105	W1-2	
33	FEED INLET	1	54-105	W1-2	
34	FEED INLET	1	54-105	W1-2	
35	FEED INLET	1	54-105	W1-2	
36	FEED INLET	1	54-105	W1-2	
37	FEED INLET	1	54-105	W1-2	
38	FEED INLET	1	54-105	W1-2	
39	FEED INLET	1	54-105	W1-2	
40	FEED INLET	1	54-105	W1-2	
41	FEED INLET	1	54-105	W1-2	
42	FEED INLET	1	54-105	W1-2	
43	FEED INLET	1	54-105	W1-2	
44	FEED INLET	1	54-105	W1-2	
45	FEED INLET	1	54-105	W1-2	
46	FEED INLET	1	54-105	W1-2	
47	FEED INLET	1	54-105	W1-2	
48	FEED INLET	1	54-105	W1-2	
49	FEED INLET	1	54-105	W1-2	
50	FEED INLET	1	54-105	W1-2	

PRESSON MANUFACTURING LTD.
 ENGINEERING — DESIGN — FABRICATION

AMOCO CANADA PETROLEUM CO.

PINE CREEK
 LSD 02-17-57-19 WSM

FUEL GAS SCRUBBER (V-110)
 8 5/8" OD x 3'-0" S/S x 250 PSIG @ 200°F
 219 mm OD x 914 mm S/S x 1724 kPa @ 93°C

DATE: 14/09/18

REV: 1

BY: J. L.

CHECKED BY: J. L.

APPROVED BY: J. L.

89551-211